ELECTRICAL CONSTRUCTION NOTES

- I. THE GENERAL CONDITIONS AND SUPPLEMENTARY GENERAL CONDITIONS SHALL BE CONSIDERED AS PART OF THE
- 2. FURNISH ALL LABOR, MATERIALS, EQUIPMENT AND TOOLS TO PERFORM ELECTRICAL WORK SHOWN, NOTED OR SCHEDULED FOR A COMPLETE AND FINISHED INSTALLATION. A. ALL MATERIALS AND EQUIPMENT SHALL BE COMMERCIAL AND SHALL CARRY A U.L. LABEL.
 - B. MATERIALS, PRODUCTS AND EQUIPMENT, INCLUDING ALL COMPONENTS THEREOF, SHALL BE NEW AND SUCH AS
 - APPEAR ON THE UNDERWRITER'S LABORATORIES LIST OF APPROVED ITEMS AND SHALL MEET REQUIREMENTS OF ASTM, IEEE, 2008 NEC, NEMA, AND OTHER RECOGNIZED STANDARDS AND SHALL BE SIZED IN CONFORMITY WITH REQUIREMENTS OF THE NATIONAL ELECTRIC CODE AND OTHER APPLICABLE CODES, WHICHEVER ARE MORE STRINGENT.
- 3. THE WORD "PROVIDE" AS USED HEREIN MEANS TO FURNISH AND INSTALL COMPLETE.
- 4. THE PROJECT SHALL COMPLY WITH TITLE-24 STANDARDS, INCLUDING 2010 CALIFORNIA BUILDING CODE (CBC). ALL WORK TO BE IN ACCORDANCE WITH THE 2010 CEC AND ALL APPLICABLE FEDERAL, STATE AND LOCAL CODES.
- 5. CONTRACTOR SHALL SECURE AND PAY FOR ALL REQUIRED PERMITS AND INSPECTION CERTIFICATES.
- 6. ABOVE GRADE CONDUIT SHALL BE STANDARD RIGID STEEL ACCORDING TO CODE REQUIREMENTS. CONDUIT SHALL BE CONCEALED IN FINISHED AREAS, EXCEPT AS OTHERWISE APPROVED BY ARCHITECT. RIGID CONNECTIONS SHALL BE COMPRESSION TYPE. UNDERGROUND CONDUIT SHALL BE SCHEDULE 40 OR 80 PVC BURIED A MINIMUM OF 24".
- 7. WIRE SHALL BE COPPER CONDUCTORS WITH 600 VOLT INSULATION. ALUMINUM CONDUCTORS ARE NOT PERMITTED. #10 AND LARGER SHALL BE STRANDED. MINIMUM WIRE SIZE SHALL BE #10. ALL WIRE AND CABLE SHALL BE NEW AND SHALL BE BROUGHT TO THE SITE IN UNBROKEN PACKAGES. ALL WIRING OF ANY TYPE SHALL BE IN CONDUIT. A. GENERAL WIRING SHALL BE THWN OR THHN.
- 8. ABOVE GRADE WIRE CONNECTORS SHALL BE BY "SCOTCHLOCK" OR EQUAL FOR #8 OR SMALLER AND T&B "LOCK-TITE" FOR #6 AND
- 9. THIS CONTRACTOR SHALL DO ALL CUTTING, CHASING OR CHANNELING AND PATCHING REQUIRED FOR ANY WORK UNDER THIS DIVISION. ANY CUTTING SHALL HAVE PRIOR APPROVAL OF THE OWNER.
- 10. PROVIDE SAFETY AND DISCONNECT SWITCHES, SHALL BE FUSED OR NON-FUSED AS CALLED FOR ON DRAWINGS AND AS REQUIRED BY CODE. SWITCHES SHALL BE HEAVY DUTY, LOAD AND HORSEPOWER RATED AS MANUFACTURED BY SQUARE D, GENERAL ELECTRIC
- II. JUNCTION, PULL BOXES AND COVERS SHALL BE GALVANIZED STEEL, CODE GAUGE SIZE AND ACCESSIBLE. 12. ELECTRICAL CONTRACTOR SHALL RECORD ALL FIELD CHANGES IN HIS WORK AS THE JOB PROGRESSES, AND UPON COMPLETION
- SHALL TURN OVER TO THE OWNER A "RECORD" SET OF PRINTS SHOWING THE CHANGES. 13. ALL ELECTRIC WORK SHALL BE INSTALLED SO AS TO BE READILY ACCESSIBLE FOR OPERATING, SERVICING MAINTAINING AND REPAIRING. HANGERS SHALL INCLUDE ALL MISCELLANEOUS STEEL, SUCH AS CHANNELS, RODS, ETC., NECESSARY FOR THE INSTALLATION OF WORK AND SHALL BE FASTENED TO STEEL, CONCRETE OR MASONRY, BUT NOT TO PIPING. ALL CONDUIT SHALL BE CONCEALED WHERE POSSIBLE. EXPOSED CONDUITS SHALL BE IN STRAIGHT LINES PARALLEL WITH OR AT RIGHT ANGLES TO COLUMN LINES OR BEAMS AND SEPARATED AT LEASED 3" FROM WATER LINES WHEREVER THEY RUN ALONGSIDE OR ACROSS SUCH LINES. CONDUCTORS SHALL BE ON CONDUIT, DUCTS, OR APPROVED RACEWAYS.
- 14. ALL 90 DEGREE ELBOWS TO BE FACTORY MADE BENDS.
- 15. PRIVATE LIGHTING SYSTEM SHALL NOT BE JOINT TRENCH WITH PUBLIC UTILITY SYSTEM.
- 16. CONTRACTOR TO MAINTAIN PROPER SEPARATION AS REQUIRED BY THE UTILITY COMPANIES.
- 17. CONTRACTOR SHALL BE RESPONSIBLE FOR CALLING FOR ANY AND ALL UTILITY AND CITY INSPECTIONS. 18. ALL GROUND CONDUCTORS SHALL BE SPLICED TOGETHER WITH APPROVED CONNECTOR AT PULL BOXES AND CONNECTED TO
- 19. SEE IMPROVEMENT PLANS FOR SITE, SEWER AND WATER (ETC.) IMPROVEMENTS PRIOR TO START OF CONSTRUCTION.
- 20. CONTRACTOR SHALL CONTACT "DIG ALERT" FOR MARK-OUT PRIOR TO TRENCHING AS REQUIRED.
- 21. THESE PLANS ARE SCHEMATIC AND ARE FOR THE PURPOSE OF SHOWING HOW TO CONNECT THE ELECTRICAL SYSTEM. WHILE THE DRAWING IS AT ACTUAL SCALE, THE SYMBOLS REFERENCED ARE NOT, AND MAY APPEAR TO SHOW THE EQUIPMENT IN PLACES NOT INTENDED. THE CONTRACTOR IS TO FIELD VERIFY ALL UTILITY COMPANY SERVICE POINTS/METER LOCATIONS, POLES, PULL BOXES BUILDING LIGHT LOCATIONS, SERVICE EQUIPMENT LOCATIONS AND OTHER ELECTRICAL APPURTENANCES PRIOR TO START OF CONSTRUCTION. ANY DISCREPANCIES ARE TO BE ADDRESSED TO THE CITY BY MEANS OF A "REQUEST FOR INFORMATION" (RFI). CONTRACTOR IS TO VERIFY ALL LIGHT LOCATIONS WITH THE CITY PRIOR TO START OF CONSTRUCTION AND DURING STAKING. REFER TO LIGHT STANDARD DETAIL FOR STANDARDS.
- CONTRACTOR SHALL CONTACT "DIG ALERT" FOR MARK-OUT PRIOR TO TRENCHING AS REQUIRED.
- 22. PANEL CIRCUIT DIRECTORY TO COMPLY WITH SECTION 408.4, CEC.
- 23. NATIVE SOIL SHALL BE ACCEPTABLE FOR TRENCH BACK FILL PROVIDED THAT THE FILL MATERIAL USED SHALL PASS THROUGH A I" SIEVE. SEE NOTES \$ DETAIL C/EL-03.
- 24. CONTRACTOR SHALL LABEL EACH CIRCUIT WITH PHENOLIC PLASTIC LABEL TAGS IN ANY DEVICE THAT HAS ACCESS. THIS SHALL INCLUDE LIGHT POLES, PULL BOXES, PANELS, AND ETCETERA. PANEL, CIRCUIT NUMBER AND VOLTAGE SHALL BE IDENTIFIED. TAGS SHALL BE AFFIXED WITH NYLON ZIP-TIES.

SPECIFICATIONS

- I. ALL PULL BOXES TO BE TYPE 3-1/2 PB (10-1/2" X 17-1/2" X 12"D) WITH CONCRETE BOLT DOWN COVER MARKED "ELECTRICAL" (BL WALLACE DISTRIBUTION (714) 761-2071, BOX-C9EB, LID-C9ROG). LEAVE 3' SLACK OF CONDUCTORS IN PULLBOX. SIZE PER SECTION 370-28, CEC. PROVIDE WITH McCAIN VANDAL RESISTANT PULL BOX INSERTS. 760/727-8100.
- 2. FUSE HOLDERS TO BE WATERPROOF AND UL LISTED.
- 3. ALL CONDUIT BELOW GRADE TO BE MINIMUM I" PVC SCHEDULE 40.
- 4. ALL SPLICES BELOW GRADE SHALL BE MADE IN APPROVED PULL BOXES AND SHALL BE WATERTIGHT. USE ONLY EPOXY ENCAPSULATED TYPE 3M BAGS OR EQUAL.
- 5. ALL BELOW GRADE CONDUIT SHALL BE SEALED UPON COMPLETION OF INSTALLATION.
- 6. ALL ELECTRICIANS TO HAVE PROOF OF CALIFORNIA ELECTRICIANS CERTIFICATE/CREDENTIALS.

BELOW GRADE ELECTRICAL CONDUIT AND WIRE RUN. SEE PLANS FOR TYPE AND # OF WIRES.



SCE SERVICE POINT. VERIFY EXACT LOCATION WITH UTILITY WORK ORDER.



400A, 3Ø, 4W, 277/480V SWITCHGEAR MMS I. SEE PLAN FOR LOCATION AND A/EL-03 FOR SCHEDULES AND DETAILS



CONCRETE UNDERGROUND PULLBOX. SEE SPEC. I AND DETAIL B/EL-03.

TYPE 'A', 9 HEAD MUSCO SPORT LIGHT WITH POLE DESIGNATION.

MMS I - I CIRCUIT DESIGNATION. IST # INDICATES PANEL. REMAINING #'S INDICATE CIRCUIT POSITIONS.




TYPE 'C', SITE LIGHT ATTACHED TO MUSCO SPORT LIGHT WITH POLE SEE SCHEDULE AND DETAIL E/EL-O3

IRRIGATION CONTROLLER. VERIFY EXACT LOCATION.

TORRANCE COMMUNITY

SPORTS PARK

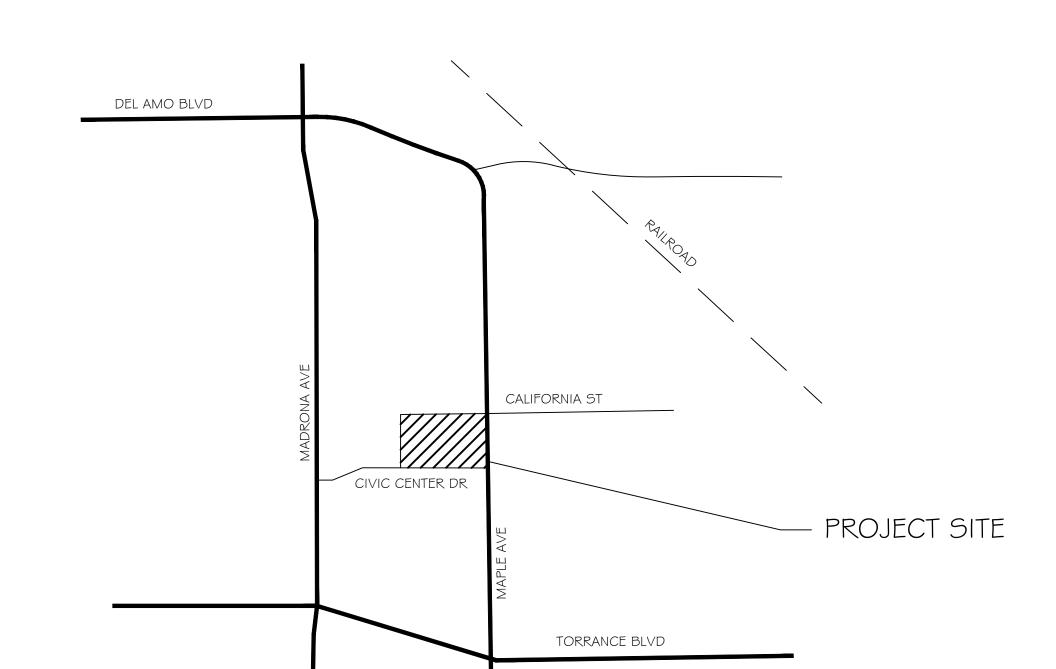


	SHEET INDEX
SHEET #	DESCRIPTION
EL-O I	NOTES, SPECS, LEGEND, SCHEDULE
EL-02	LIGHTING PLAN
EL-03	INSTALLATION DETAILS
EL-04	MUSCO INSTALLATION DETAILS

LUN	IINAIRE	SCHEDI	JLE							
COUNT	TYPE	SYMBOL	FIXTURE	VOLTS	LAMPS		MOUN	TING		
			HALOG INDUC LED LPS MH HPS	120 240 12 180	OZ TYPE	WATTS	WELL SURF	WALL	DESCRIPTION	MFR \$ CATALOG NO.
10	$\langle A \rangle$	•			9 I 500 MH	5400			SPORTS LIGHTS-36 LIGHTS SEE DETAIL D/EL-04	MUSCO SPORTS LIGHTING (PROJECT# 163165) LSG80AA-1500W-9 (POLES 51-510)
ı	$\langle B \rangle$	Ď			40 LED	<u></u>			SITE LIGHTS- SEE DETAIL E/EL-03	CREE LED STR-LWY-3M-DA-04-E-UL-BZ-700-40K-ML POLE-PS4S20C-I-BZ ADAPTER-PD-IHR-BZ
6	$\langle C \rangle$	Q			40 LED	<u></u>			SITE LIGHTS- SEE DETAIL E/EL-03 (MOUNTED TO MUSCO POLE)	CREE LED STR-LWY-3M-DA-04-E-UL-BZ-700-40K-ML ADAPTER-SIDE POLE MOUNTED-BZ

* DISTRIBUTOR TO CALL TOM BRINDLY OF WESTERN LIGHT SOURCE (702-466-2120) FOR CREE LED PRICING.



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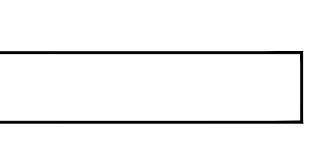
REVISIONS

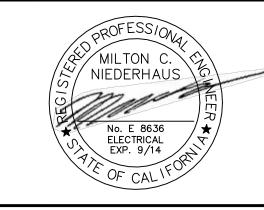. IST SUBMITTAL 6-10-13

2. CITY PLAN CHECK REV. 7-23-13


3. PLAN REV. 8-28-13

4. PLAN REV. 8-29-13





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PLAN NOTES

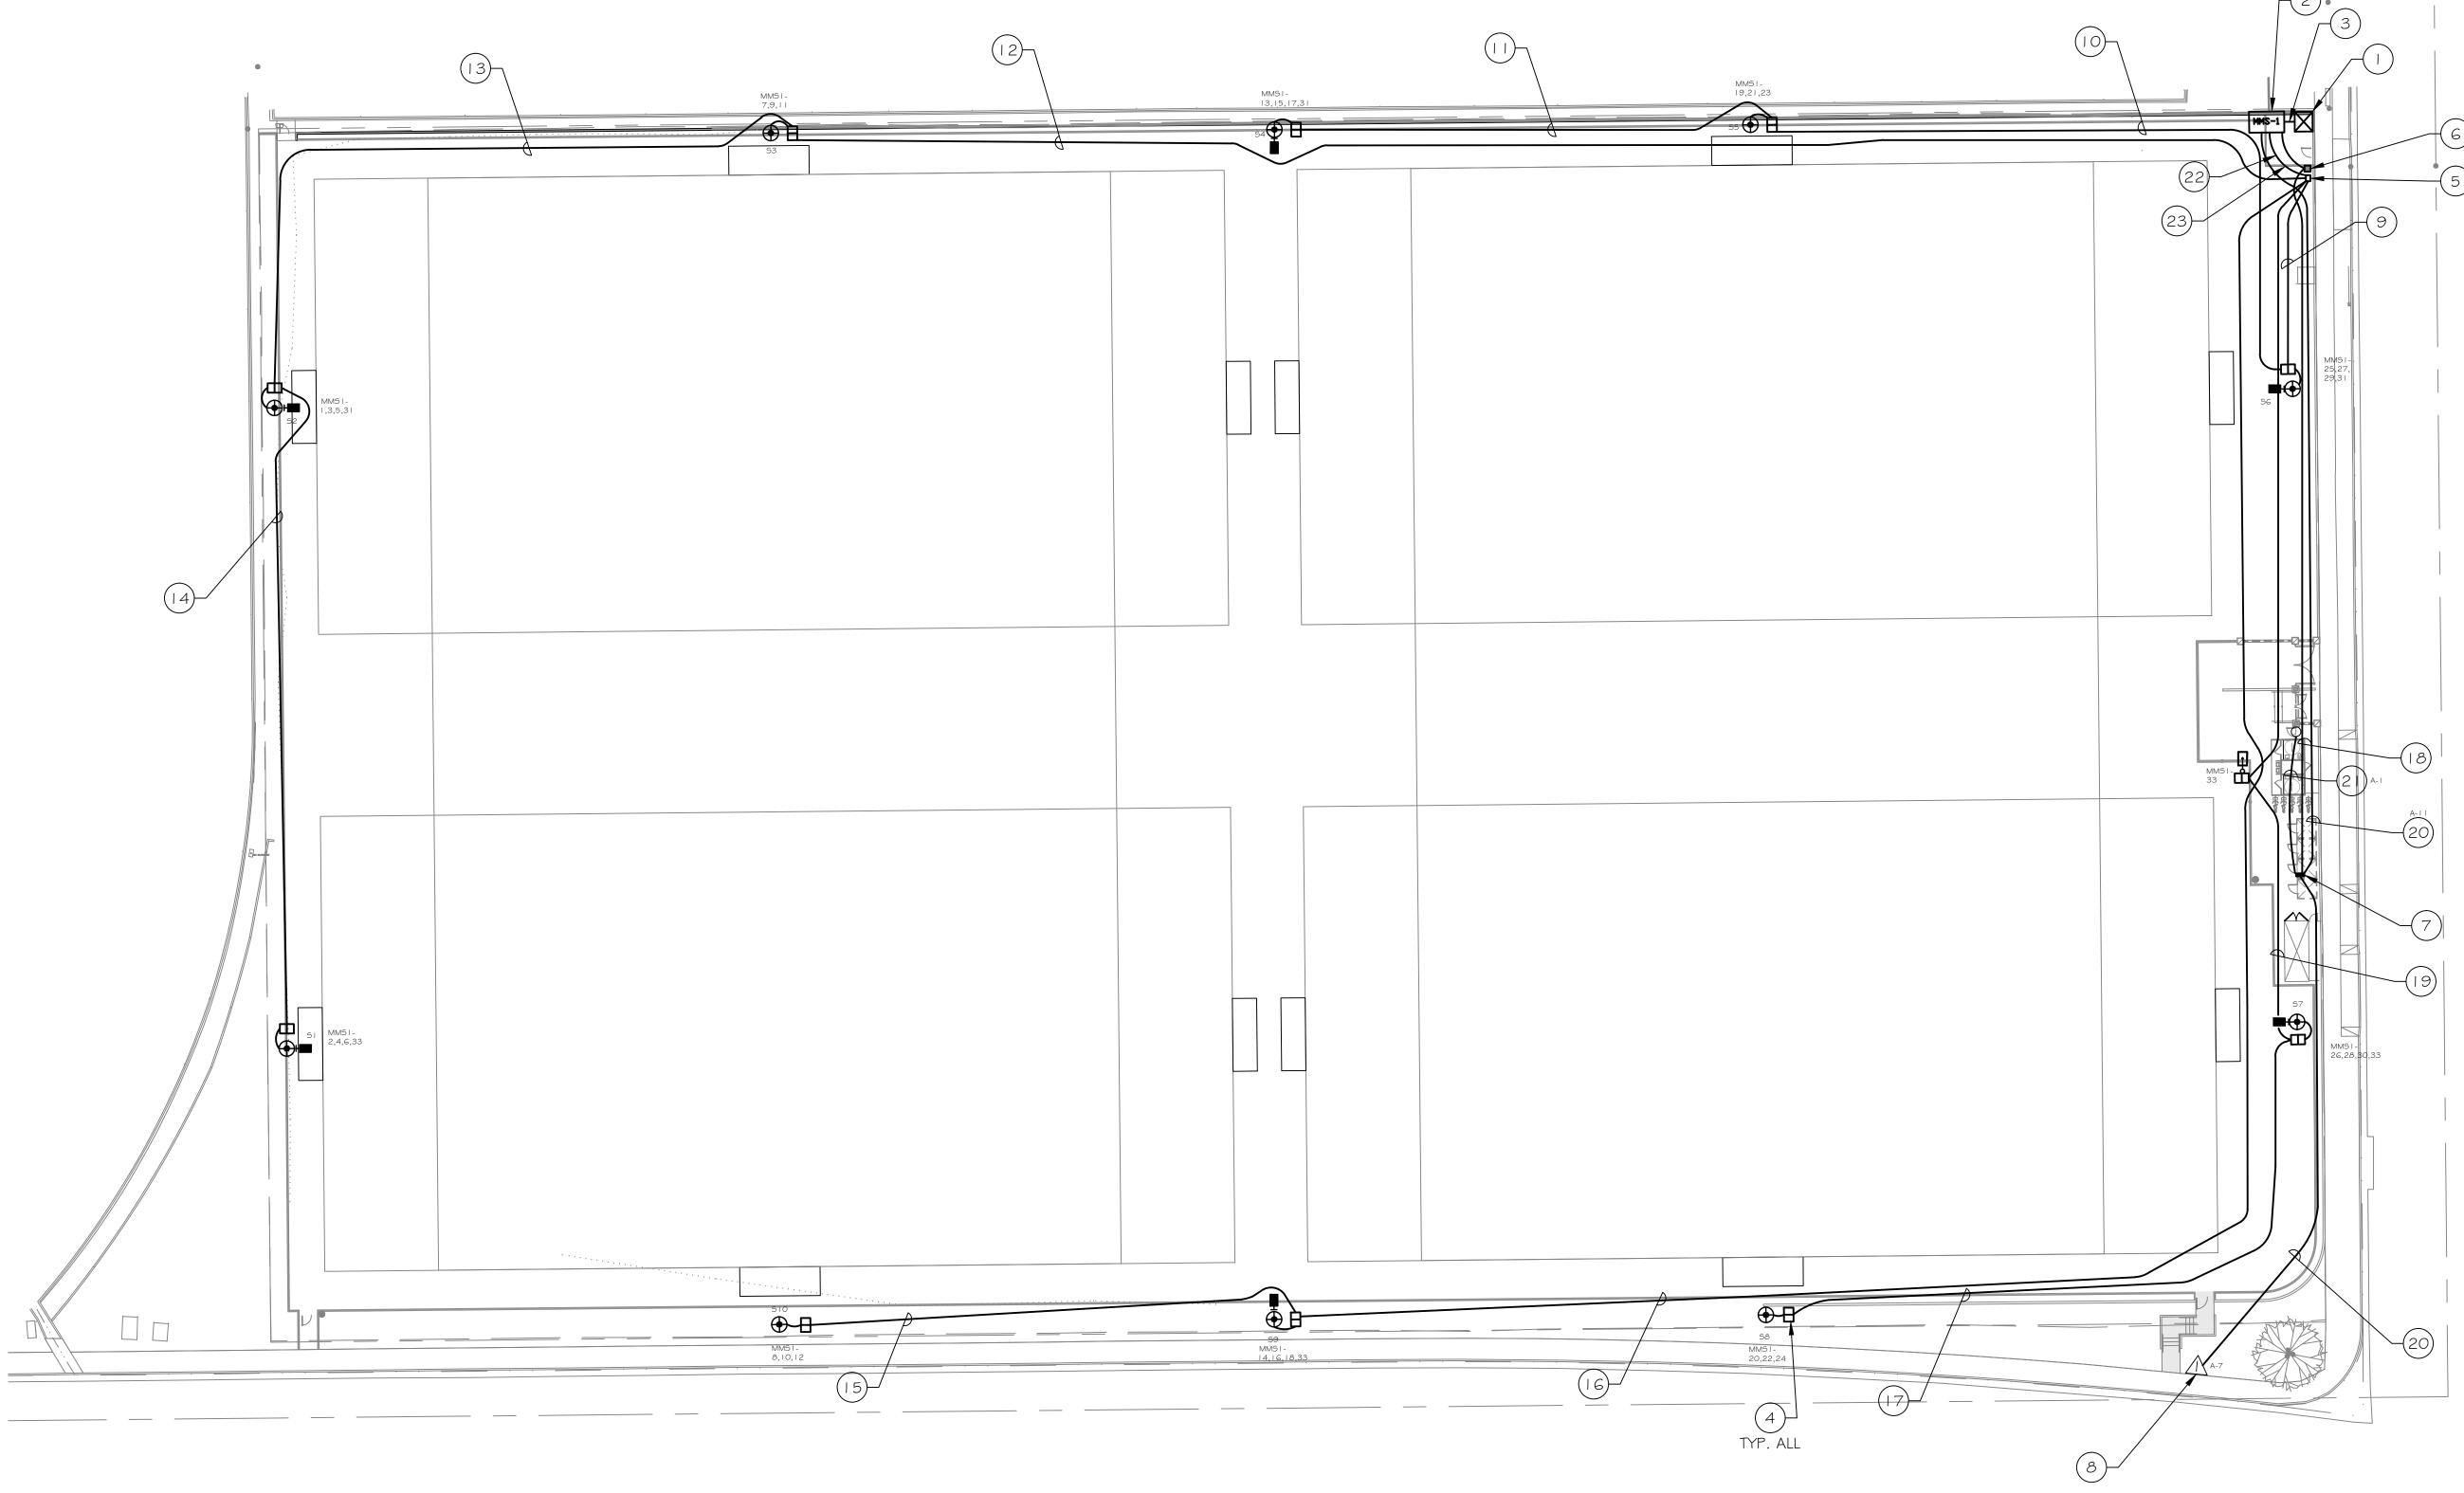- SCE TRANSFORMER. SEE SCE WORK ORDER FOR INSTALLATION REQUIREMENTS.
- 277/480V, 400A, 3Ø, 4W SWITCHGEAR MMS I. SEE DETAIL A/EL-3.
- PROVIDE DB CONDUIT ONLY WITH 3/16" POLY-PROPYLENE PULL ROPE. INSTALL PER SCE WORK ORDER.
- PROVIDE CONCRETE UNDERGOUND PULLBOX WITH EVERY LIGHT POLE. SEE SPEC. I AND DETAIL B/EL-03.
- MUSCO SPORTS LIGHTING CONTROL CABINET. SEE 1-LINE DIAGRAM DETAIL A & D/EL-3 AND CONTROLS SUMMARY ON SHEET EL-03.
- 6 480-120/240V STEP-DOWN TRANSFORMER 'T I '. SEE I-LINE DIAGRAM DETAIL A \$ F/EL-O.
- 7 EXISTING I 20/240V PANEL 'A' SUPPLIED AND INSTALLED BY BUILDING MANUFACTURER. CONTRACTOR TO MAKE ELECTRICAL CONNECTION IN
- PULL BOX. (8) IRRIGATION CONTROLLER. VERY EXACT LOCATION WITH LANDSCAPE PLANS
- 9 PROVIDE 2"C-14#8 (MMS1-13,15,17 (2 SETS OF SWITCH-LEGS FOR POLE 54),19,21,23,25,27,29,31), 1#8 GND. BURY 24" BELOW GRADE.
- PROVIDE 2"C-11#8 (MMS1-13,15,17 (2 SETS OF SWITCH-LEGS FOR POLE S4),19,21,23,31), 1#8 GND. BURY 24" BELOW GRADE. (II) PROVIDE 2"C-3#8 (MMSI-13,15,17 (2 SETS OF SWITCH-LEGS FOR POLE
- 54), 31), 1#8 GND. BURY 24" BELOW GRADE.

- PROVIDE 2"C-9#6 (MMS1-1,3,5,7,9,11,2,4,6), 3#8 (MMS1-31,33),1#8 GND. BURY 24" BELOW GRADE.
- PROVIDE 2"C-6#6 (MMSI-1,3,5,7,2,4,6), 3#8 (MMSI-31,33), I#8 GND. BURY 24" BELOW GRADE.
- PROVIDE 2"C-3#6 (MMSI-2,4,6), 2#8 (MMSI-33), I#8 GND. BURY 24"
- PROVIDE 2"C-3#6 (MMS1-8,10,12),1#8 GND. BURY 24" BELOW GRADE.
- PROVIDE 2"C-9#6 (MMS | -8, | 0, | 2, | 4, | 6 (2 SETS OF SWITCH-LEGS FOR POLE S9), | 8), 2#8 (MMS | -33), | #8 GND. BURY 24" BELOW GRADE.
- (17) PROVIDE 2"C-3#6 (MM51-20,22,24), 1#8 GND. BURY 24" BELOW GRADE.
- PROVIDE I 1/4"C-3#4, 1#8 GND. BURY 24" BELOW GRADE.
- PROVIDE 2"C-6#6 (MMS1-20,22,24), 5#8 (MMS1-26,28,30,33),1#8 GND. BURY 24" BELOW GRADE.
- PROVIDE 1"C-2#8, 1#10 GND. BURY 24" BELOW GRADE.
- PROVIDE 3/4"C-2#10, 1#10 GND. BURY 24" BELOW GRADE. FUTURE SIGN POWER. JUNCTION BOX SHALL BE RECESSED INTO SIDE OF COLUMN, WITH 1/2" PVC STUBBED TO TOP OF COLUMN, EXPOSED AND CAPPED.

LEGEND

BELOW GRADE ELECTRICAL CONDUIT AND WIRE RUN. SEE PLANS FOR TYPE AND # OF WIRES.



400A, 3Ø, 4W, 277/480V SWITCHGEAR MMS I. SEE PLAN FOR LOCATION AND A/EL-03 FOR SCHEDULES AND DETAILS

MMS I - I CIRCUIT DESIGNATION. IST # INDICATES PANEL. REMAINING #'S INDICATE CIRCUIT POSITIONS.

CONCRETE UNDERGROUND PULLBOX. SEE SPEC. I AND DETAIL B/EL-03.

TYPE 'A', 9 HEAD MUSCO SPORT LIGHT WITH POLE DESIGNATION.

TYPE 'B', SITE LIGHT. SEE SCHEDULE AND DETAIL E/EL-03

TYPE 'C', SITE LIGHT ATTACHED TO MUSCO SPORT LIGHT WITH POLE SEE SCHEDULE AND DETAIL E/EL-O3

IRRIGATION CONTROLLER. VERIFY EXACT LOCATION.

P IRRIGATION BOOSTER PUMP. VERIFY EXACT LOCATION.

JUNCTION BOX FOR FUTURE SIGN CONNECTION.




project manager: K. PEREZ

approved by: M. NIEDERHAUS drawn by:

K. PEREZ 08/14/13

scale: 1"=30'

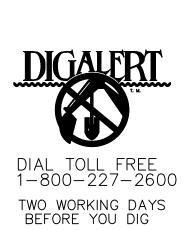


3. PLAN REV. 8-28-13 4. PLAN REV. 8-29-13


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REVISIONS

I. IST SUBMITTAL 6-10-13

2. CITY PLAN CHECK REV. 7-23-13



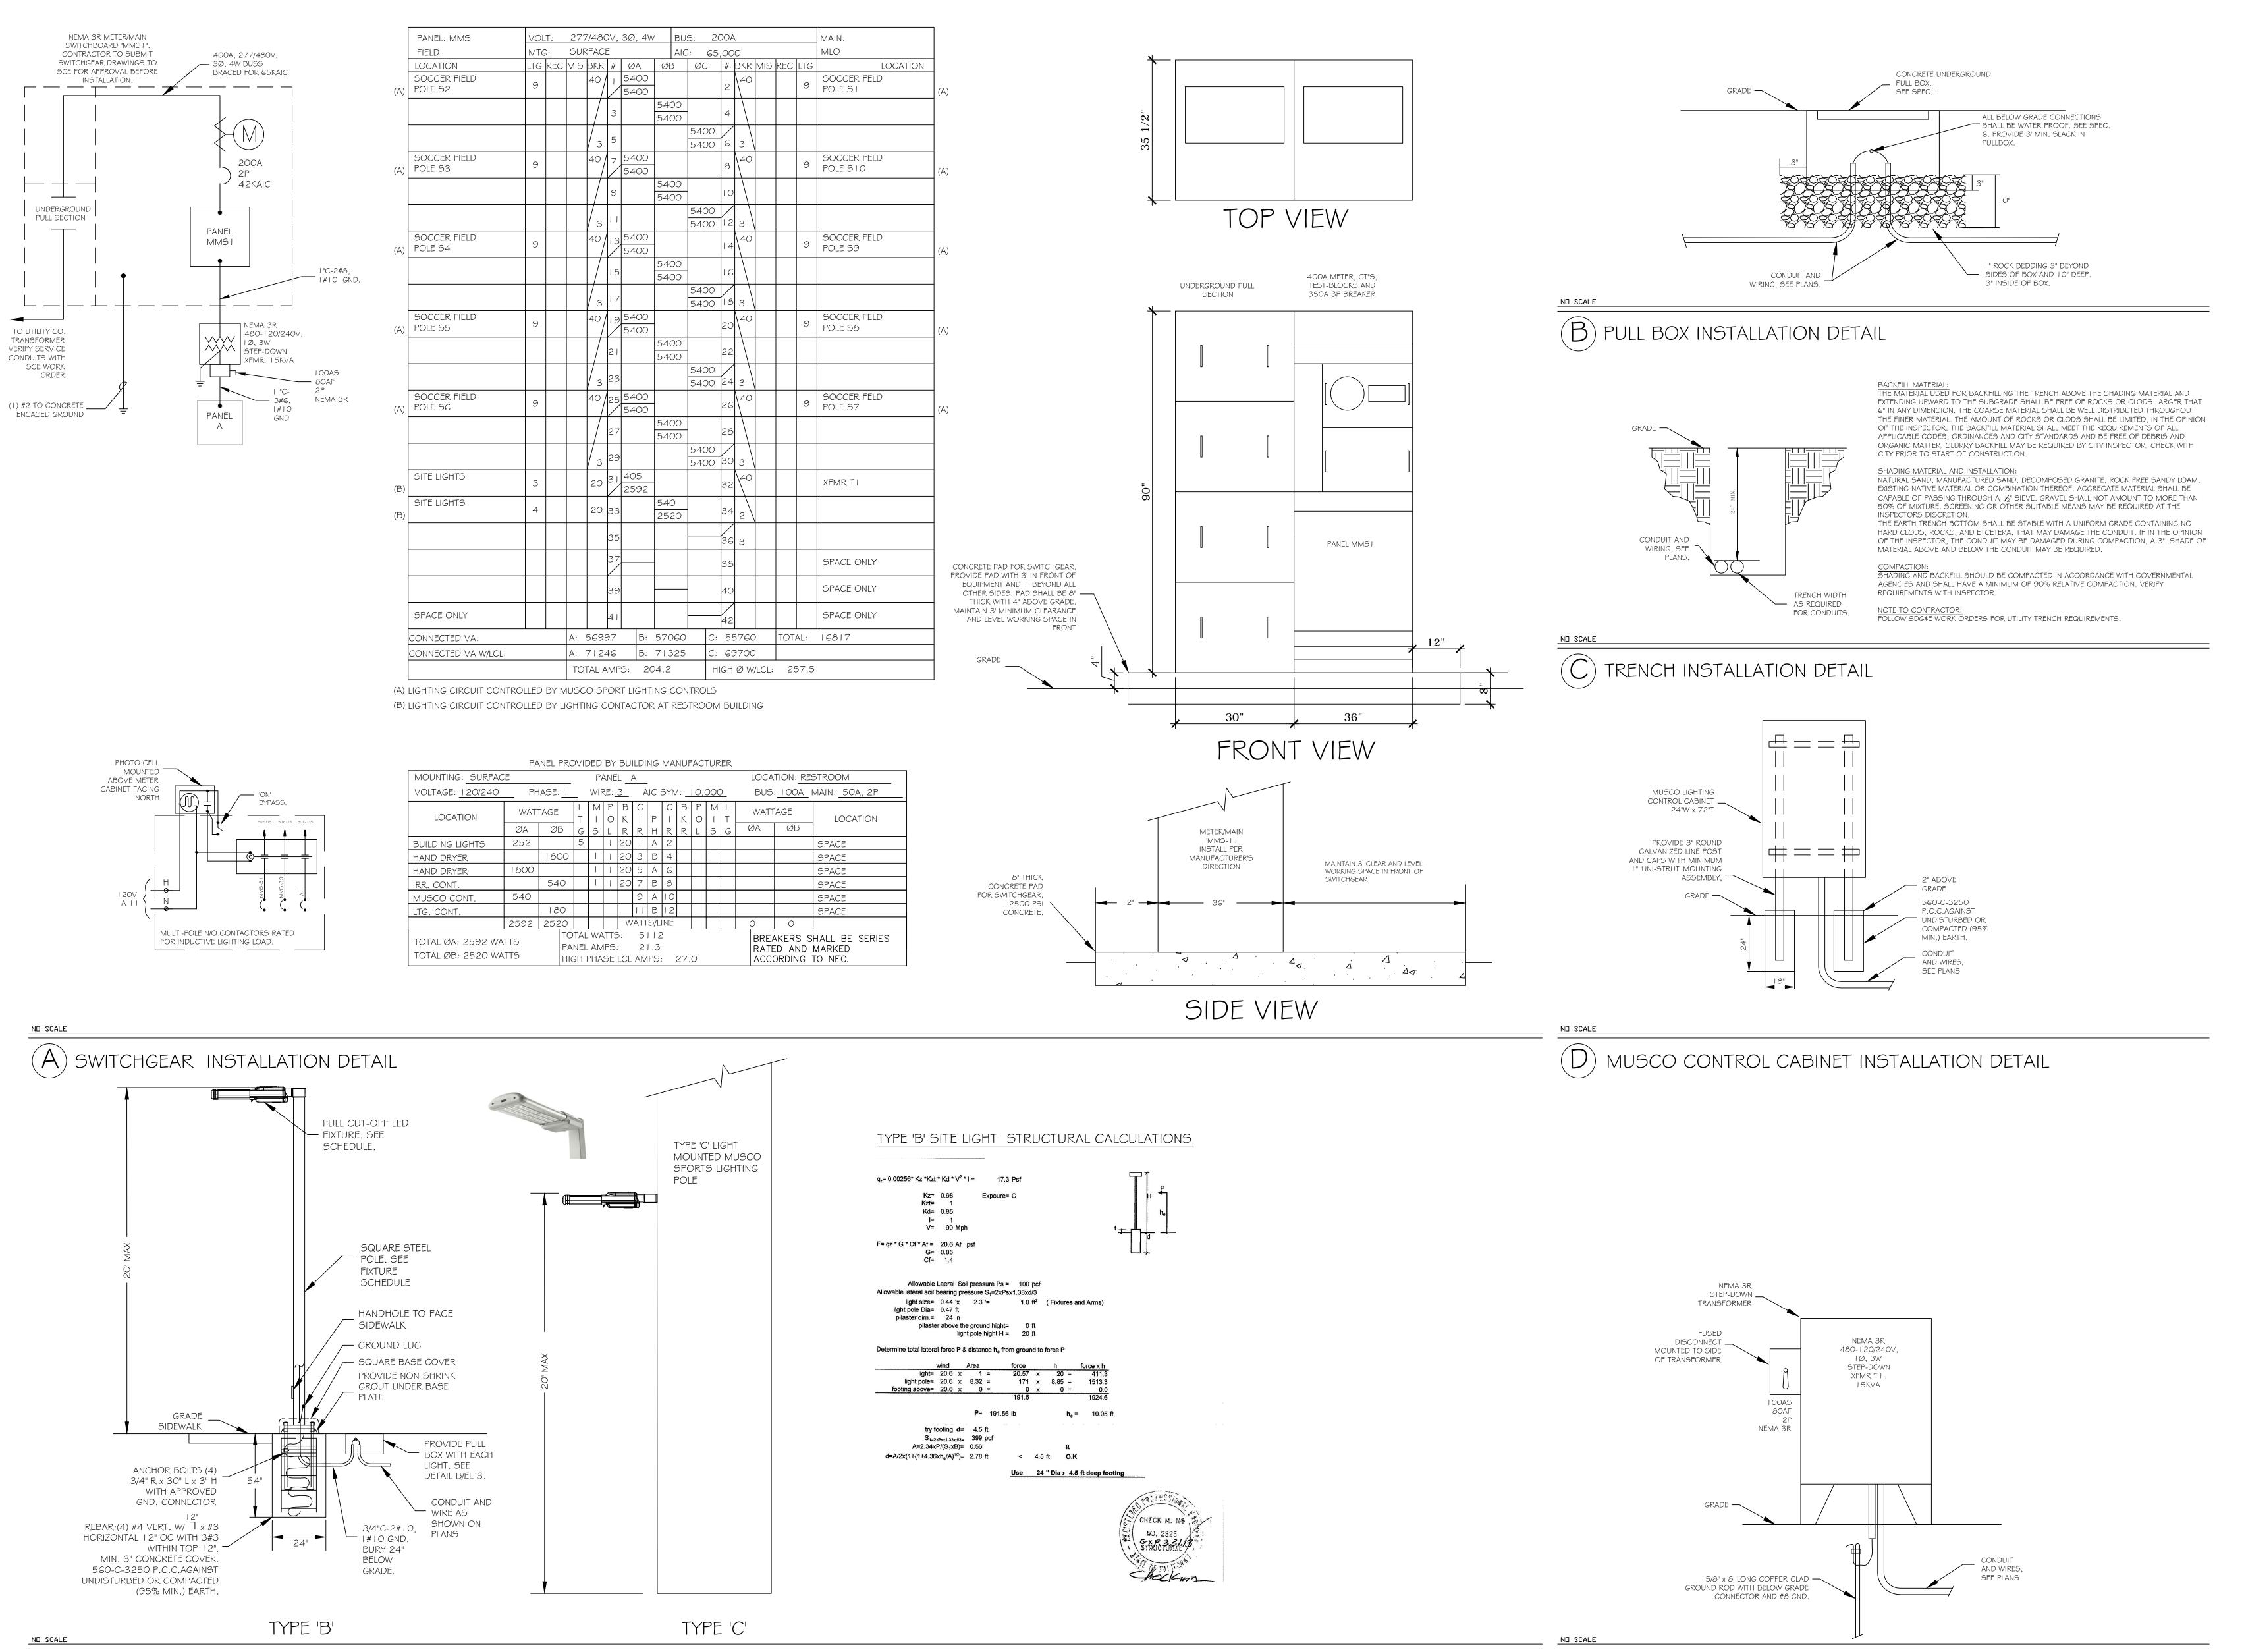

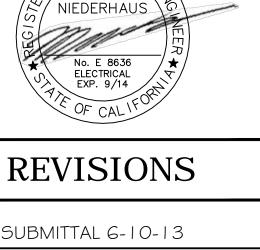1. IST SUBMITTAL 6-10-13

2. CITY PLAN CHECK REV. 7-23-13

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3. PLAN REV. 8-28-13

4. PLAN REV. 8-29-13

TRANSFORMER INSTALLATION DETAIL

PRODUCERS OF LIGHTING FUSION PN:050-270-4503 F0X:050-270-4573 7207 RONSON Rd. SUITO [| 50N DIOQO, Cd. 02111 WWW.VISUALCONCEPTS-NC.COM

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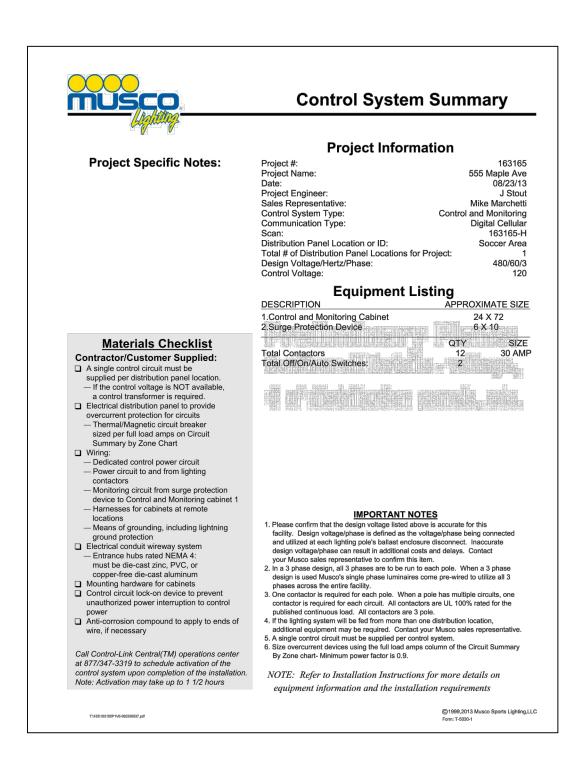
|project manager: K. PEREZ approved by: M. NIEDERHAUS

drawn by: K. PEREZ

08/14/13

N/A

(E) TYPE 'B', 'C' SITE LIGHT INSTALLATION DETAIL



Control System Summary

555 Maple Ave / 163165 - 163165-H
Soccer Area - Page 2 of 4

Control-Link - Control and Monitoring System — Digital Cellular

Control-Link - Control and Monitoring System — Digital Cellular

Control-Link - Control and Monitoring System — Digital Cellular

Control-Link - Control and Monitoring System — Digital cellular


Control-Link - Control and Monitoring System — Digital cellular

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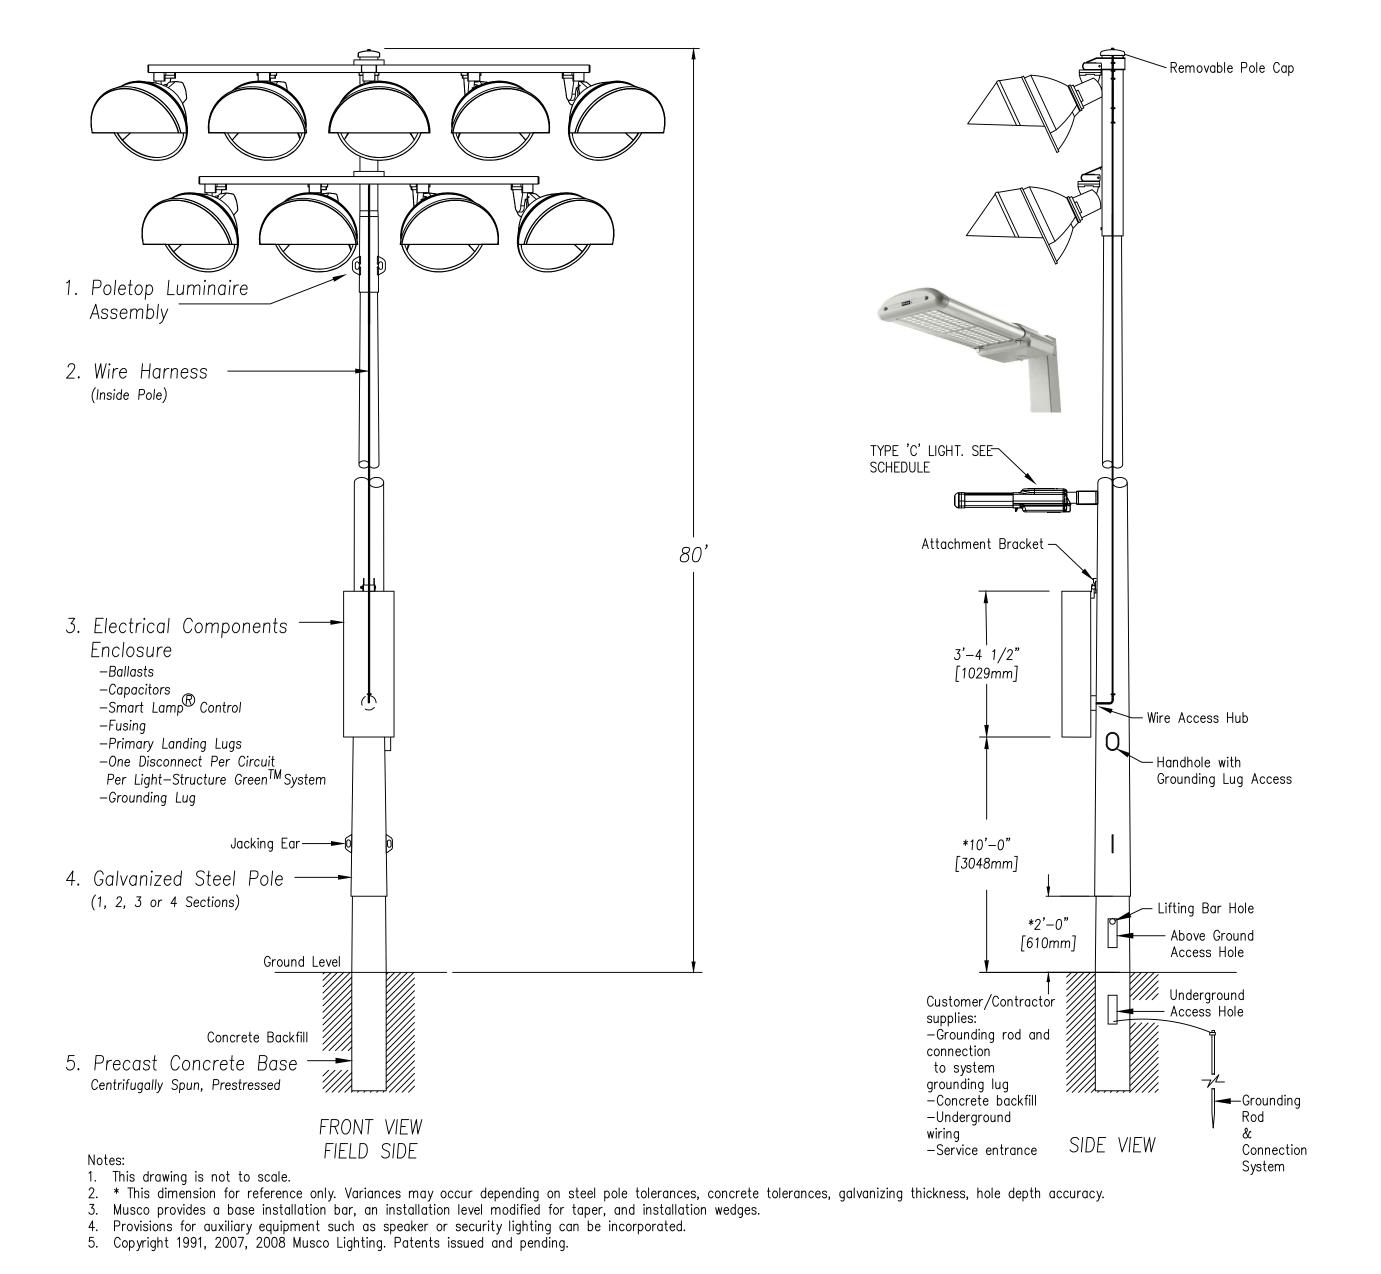
PROJECT INFORMATION MATERIALS CHECKLIST, EQUIPMENT LISTING

PANEL SUMMARY, ZONE SCHEDULE

CONTROL-LINK, CONTROL AND MONITORING SYSTEM - DIGITAL CELLULAR

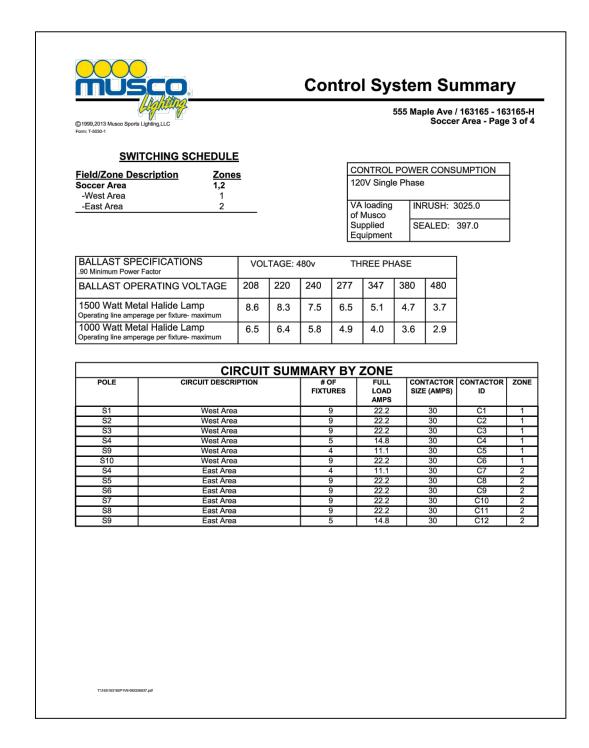

SWITCHING SCHEDULE, CIRCUIT SUMMARY



TYPE 'A' SPORTS LIGHT INSTALLATION DETAIL-9 LIGHTS PER POLE

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ELECTRICAL EXP. 9/14 OF CALLED
REVISIONS
ST SUBMITTAL 6-10-13
CITY PLAN CHECK REV. 7-23-13

4. PLAN REV. 8-29-13

3. PLAN REV. 8-28-13

S MAPLE AVENUE

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-PRODUCERS OF LIGHTING FUSION
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WWW.VISUALCONCEPTS-INC.COM

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